WIRING ACCESSORIES

s.no	SYMBOLS	DESCRIPTION	MAKE	MOUNTING HEIGHT
1	↓ S1-4	INDICATES GANG TYPE SWITCH 10 AMPS, INDICATES NUMBER OF SWITCHES ON SWITCH PLATE	-CLIPSAL -LEGRAND -ORANGE	3'-6" F.F.L
2	(TWO WAY)	INDICATES 2 WAY GANG TYPE SWITCH 10 AMPS,	-CLIPSAL -LEGRAND -ORANGE	3'-6" F.F.L
3	D	INDICATES 16 SWG M.S SWITCH BOARD WITH PLATE	-CLIPSAL -LEGRAND -ORANGE	3'-6" F.F.L
4	<u></u>	INDICATES 3 PIN COMBINED SWITCH SOCKET 5 AMPS, ON M.S BACK BOX 3"x3"	-CLIPSAL -LEGRAND -ORANGE	0'-9" F.F.L
5	Å	INDICATES SHAVER SOCKET 10 AMPS, ON M.S BACK BOX 3"x3"	-CLIPSAL -LEGRAND -ORANGE	3'-6" A.C.L
6	₾	INDICATES SHAVER SOCKET 10 AMPS, ON M.S BACK BOX 3"x3"	-CLIPSAL -LEGRAND -ORANGE	0'-9" F.F.L
7	<u> </u>	INDICATES 3 PIN COMBINED POWER SOCKET 15 AMPS, ON M.S BACK BOX 3"x3"	-CLIPSAL -LEGRAND -ORANGE	0'-9" F.F.L
8		INDICATES WIRING IN 1" DIA PVC CONDUIT BURIED IN SLAB	-BETA -DELTA GOLD -SHAVYL	-IN WALL/ -BUF/BUG/ BIS/AFC
9		INDICATES WIRING IN 1" DIA PVC CONDUIT BURIED IN WALL	-BETA -DELTA GOLD -SHAVYL	-IN WALL/ -BUF/BUG/ BIS/AFC
10		INDICATES WIRING IN 1" DIA PVC CONDUIT BURIED UNDER FLOOR	-BETA -DELTA GOLD -SHAVYL	-IN WALL/ -BUF/BUG/ BIS/AFC
11	PVCC	INDICATES PVC CONDUIT	-BETA -DELTA GOLD -SHAVYL	-IN WALL/ -BUF/BUG/ BIS
12	F.F.L	FROM FINISHED FLOOR LEVEL	-	-
13	12"ACL	12"ABOVE COUNTER LEVEL	-	-
14		MANHOLE 18"x18x"18"(INNER SIZE) WITH WATER TIGHT R.C.C COVER	-	-
15	•	INDICATES WATER TIGHT BELL PUSH	-CLIPSAL -LEGRAND -ORANGE	ON GATE PILLAR AT 4'-6"FFL
16	● B	INDICATES BELL BUZZER ON 3"x3" M.S BOX	-CLIPSAL -LEGRAND -ORANGE	7'-0" F.F.L ON WALL
17	≥1 sac	INDICATES SPLIT AIR CONDITIONER (IN DOOR UNIT)	-	SEE ARCH DRG.
18	CON	INDICATES SPLIT AIR CONDITIONER (OUT DOOR UNIT)		

NOTE:-

SAMPLE OF WIRING ACCESSORIES SHALL BE SUBMITTED TO ARCHITECT FOR APPROVAL BEFORE INSTALLATION.

TELEPHONE SYSTEM

S.NO	SYMBOLS	DESCRIPTION	MAKE	MOUNTING HEIGHT
1	•	INDICATES TELEPHONE OUTLET ON M.S JUNCTION BOX 3"x3"	-CLIPSAL -NORDEN -MOLEX	0'-9" F.F.L
2		INDICATES TELEPHONE DISTRIBUTION BOARD	-CLIPSAL -NORDEN -MOLEX	4'-0" F.F.L
3	TJB	INDICATES TELEPHONE JUNCTION BOX MADE OF M.S BOX 16 SWG 4"x7"x4"DEEP WITH COVER TO PULL TELEPHONE CABLES.	LOCAL	0'-9" F.F.L
4		INDICATES WIRING IN 3/4" DIA PVCC FOR TELEPHONE SYSTEM	-BETA -DELTA GOLD -SHAVYL	IN WALL BUF/BUG/BIS

TV SYSTEM

S.NO	SYMBOLS	DESCRIPTION	MAKE	MOUNTING HEIGHT
1	\sim	INDICATES TV CABLE OUTLET POINT ON M.S JUNCTION BOX 3"x3"	-CLIPSAL -LEGRAND -LEGRAND	0'-9" F.F.L
2	DIS	INDICATES TV CABLE DISTRIBUTOR	-CLIPSAL -NORDEN -MOLEX	4'-0" F.F.L
3	TVJB	INDICATES TV JUNCTION BOX MADE OF M.S BOX 16 SWG 4"x7"x4"DEEP WITH COVER TO PULL TV CABLES.	LOCAL	0'-9" F.F.L
4	TV_TV_	INDICATES WIRING IN 3/4" DIA PVCC FOR TV SYSTEM	-BETA -DELTA GOLD -SHAVYL	IN WALL BUF/BUG/BIS

LED LIGHT FIXTURES

S.NO	SYMBOLS	DESCRIPTION	MOUNTING HEIGHT
1	\vdash	INDICATES MIRROR / VANITY LIGHT POINT ABOVE MIRROR	12"ABOVE MIRROR
2	\vdash	INDICATES 2' LONG LED LIGHT POINT	INSTALLED ON SLAB
3	0	INDICATES CEILING LIGHT POINT	RECESSED IN FALSE CEILING
4	0	INDICATES CEILING LIGHT POINT	ON SLAB
5	\oplus	INDICATES LIGHT POINT ON GATE PILLAR.	ON GATE PILLAR
6	Θ	INDICATES CEILING LIGHT POINT	ON SLAB
7	$\vdash \bigcirc$	INDICATES WALL LIGHT POINT	ON WALL 7'-6"FFL
8	\longmapsto	INDICATES WATER TIGHT WALL BRACKETLIGHT	ON WALL 7'-6"FFL
9	Н	INDICATES WALL HUNG LIGHTS	SEE ARCH DWG
10	H	INDICATES PICTURE TUBE LIGHT	7'-6" F.F.L ON WALL
11		INDICATES MULTI LAMP CHANDELIER	SLAB SUSPENDED
12	.	INDICATES MINII LAMP CHANDELIER	SLAB SUSPENDED
13	\bigcirc	INDICATES ADJUSTABLE SPOT LIGHT / SPIKE TYPE	ON 9"X9"X9" BRICK PEDISTAL OR IN FLOOR
14		INDICATES 48"/56"SWEEP FAN WITH 5/8" DIA M.S HOOK	SLAB SUSPENDED
15	•	INDICATES EXHAUST FAN DIA AS SHOWN ON DRAWING	8'F.F.L ON WALL OR AS REQ
16		INDICATES 24"SWEEP WALL BRACKET FAN	7'-6" F.F.L ON WALL
17	D	INDICATES ROOF WALL LIGHT POINT	-

THE ABOVE MENTIONED SYMBOLS ARE LIGHT POINTS ONLY. CLINT SHALL BUY THE LIGHT FITTINGS AS PER HIS CHOICE IN CONSULTATION WITH THE ARCHITECT.

SWITCH GEAR


S.NO	SYMBOLS	DESCRIPTION	MAKE	MOUNTING HEIGHT
1	DBLP	INDICATES DISTRIBUTION BOARD WITH MCB FOR PROTECTION OF LIGHT & POWER SOCKETS CIRCUITS	REFER TO BOQ	4'-0"F.F.L
2	R Y B ⊗⊗⊗	INDICATES PHASE INDICATION LAMPS ON DBs	REFER TO BOQ	SEE DRGS. /BOQ
3	MCCB ——X—	INDICATES MOULDED CASE CIRCUIT BREAKER - MCCB	REFER TO BOQ	SEE DRGS. /BOQ
4	-Q_X	INDICATES RESIDUAL CURRENT CIRCUIT BREAKER SENSTIVITY 300 mA	REFER TO BOQ	SEE DRGS. /BOQ
5	Ø V A	INDICATES SELECTOR SWITCH / VOLT METER / AMPERE METER SQUARE SHAPED	REFER TO BOQ	SEE DRGS. /BOQ
6	ф стѕ	INDICATES CURRENT TRANSFORMER RATIO AS SHOWN ON DRAWING	REFER TO BOQ	SEE DRGS. /BOQ

NOTE:-


- 1 MAKES OF ACCESSORIES AND EQUIPMENT IS FOR INFORMATION TO THE CLIENT, OWNER MAY BUY ACCESSORIES FROM ANY MANUFACTURER OF HIS CHOICE.
- 2 TYPE OF LIGHT FITTING SHALL BE SELECTED BY OWNER IN CONSULTATION WITH ARCHITECT.


CONSULTANT:	CLIENT:	PROJECT TYPOLOGY:
	MANZER ABBAS	RESIDENTIAL
	PROJECT LOCATION:	DRAWING TITLE:
	PLOT NO. 3 BLOCK. C NEW CHAKWAL CITY, CHAKWAL	ELECTRICAL DRAWING
	PLOT SIZE:	FLOOR PLAN:
DHARFLANS	50'-0" X 90' (20 MARLA)	GROUND FLOOR
469 BLOCK G 1 JOHAR TOWN LAHORE, PUNJAB. 54000	PLOT AREA:	COVERED AREA OF FLOOR:
WWW.GHARPLANS.PK	4500 SQFT.	SFT.

DRAWING PHASE: SHEET NO: ☐ DRAWINGS IN PROCESS
■ ISSUED FOR CONSTRUCTION P401 PROJECT ARCHITECT: AR. QURRAT-UL-AIN PROJECT NO: GP-55_MA_20M ASSISTANT ARCHITECT:
AR. WAJEEHA
DRAFTED BY: WORKING BY: SCALE: 1/8" = 1' DATE: SEPT.,2021

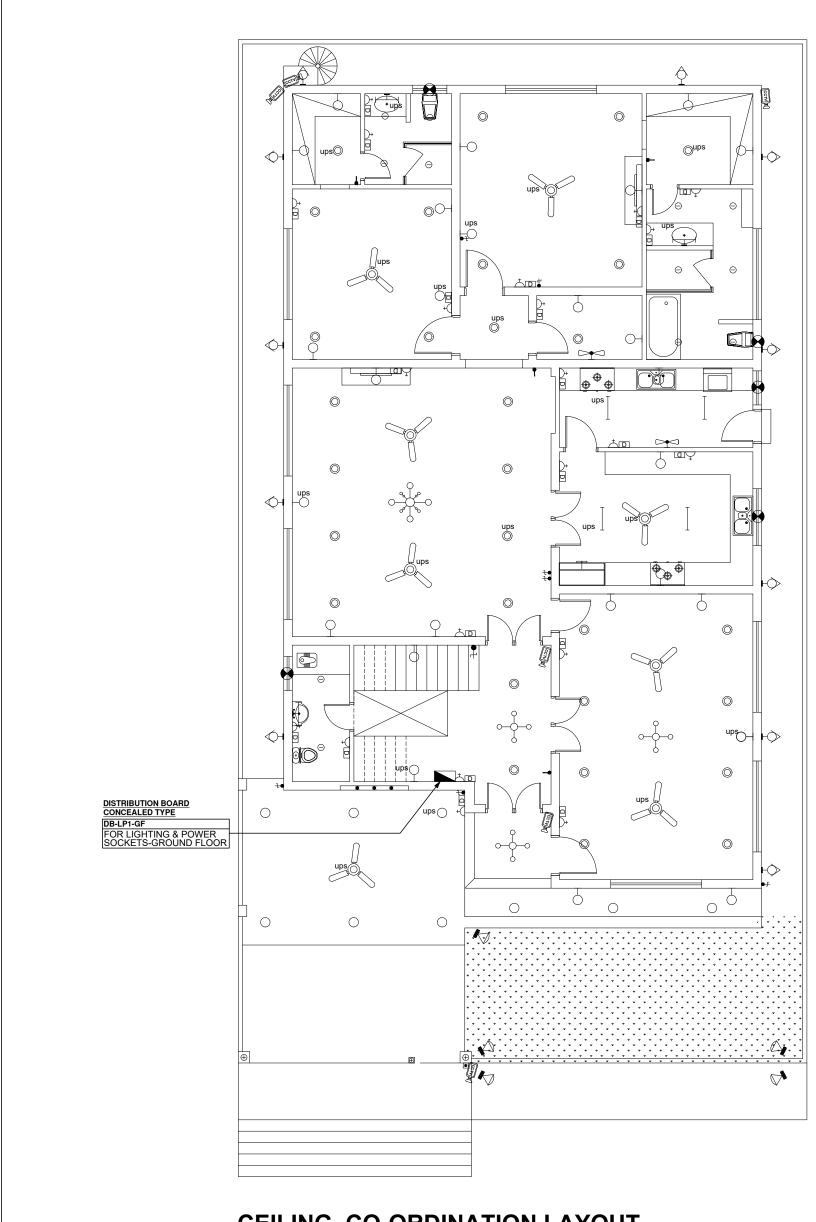



CEILING CO-ORDINATION LAYOUT

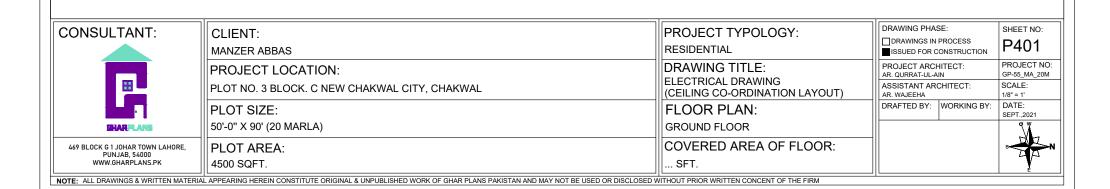

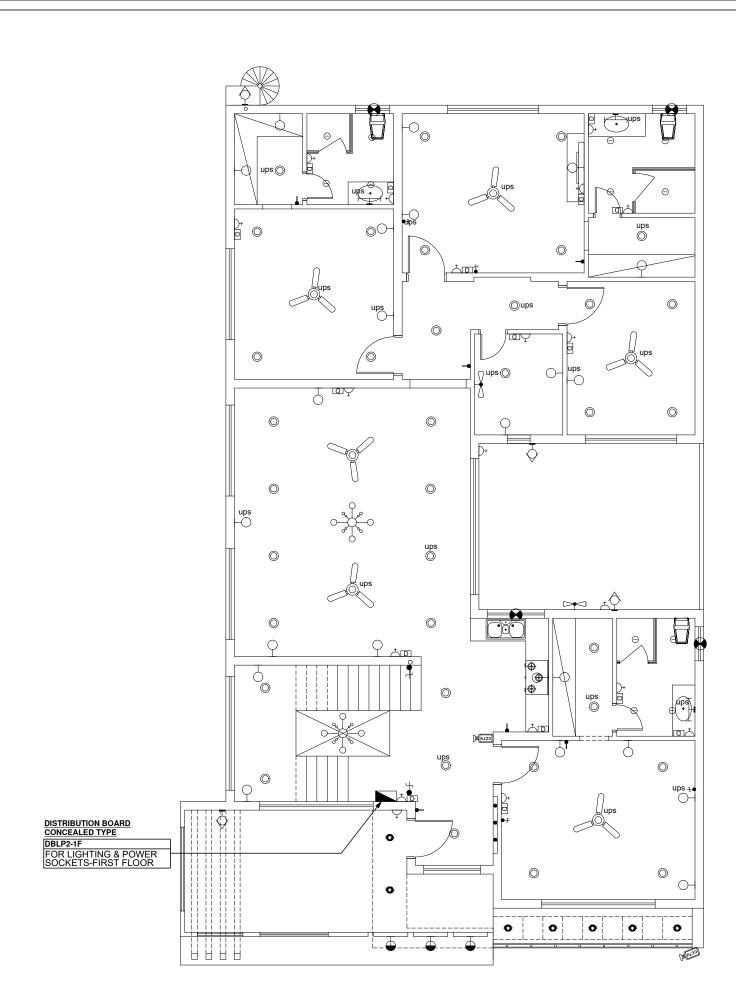

CEILING CO-ORDINATION LAYOUT

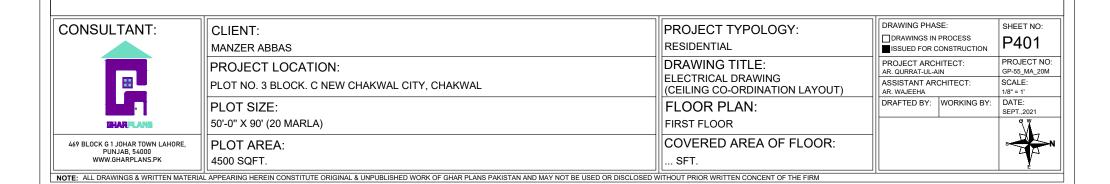

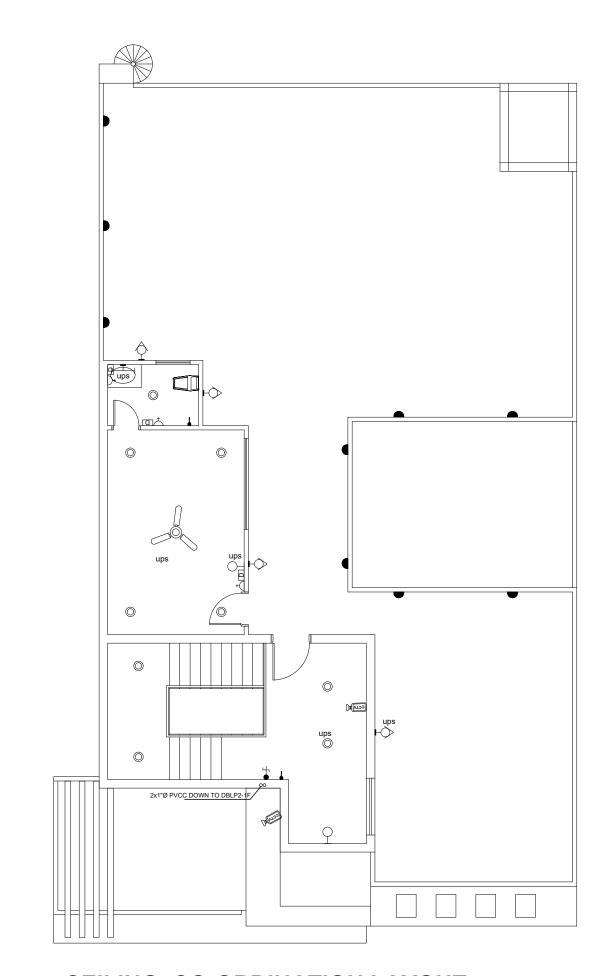

CEILING CO-ORDINATION LAYOUT



CLIENT: MANZER ABBAS PROJECT LOCATION: PLOT NO. 3 BLOCK. C NEW CHAKWAL CITY, CHAKWAL PLOT SIZE: 50'-0" X 90' (20 MARLA) PLOT AREA:

NOTE: ALL DRAWINGS & WRITTEN MATERIAL APPEARING HEREIN CONSTITUTE ORIGINAL & UNPUBLISHED WORK OF GHAR PLANS PAKISTAN AND MAY NOT BE USED OR DISCLOSED WITHOUT PRIOR WRITTEN CONCENT OF THE FIRM


4500 SQFT.

PROJECT TYPOLOGY: RESIDENTIAL DRAWING TITLE: ELECTRICAL DRAWING (CEILING CO-ORDINATION LAYOUT) FLOOR PLAN: SECOND FLOOR COVERED AREA OF FLOOR: ... SFT.


DRAWING PHASE: SHEET NO: DRAWINGS IN PROCESS ISSUED FOR CONSTRUCTION PROJECT ARCHITECT: AR. QURRAT-UL-AIN ASSISTANT ARCHITECT: AR. WAJEEHA DRAFTED BY: WORKING BY:






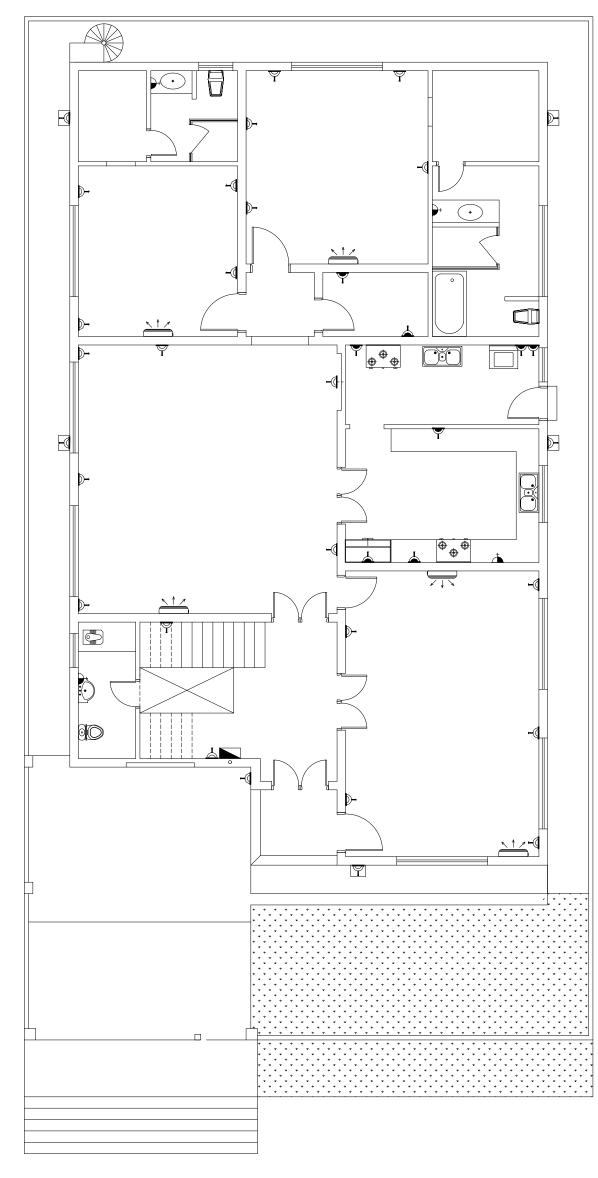



CONDUITS LAYOUT PLAN FOR POWER SOCKETS AND SPLIT AC's GROUND FLOOR

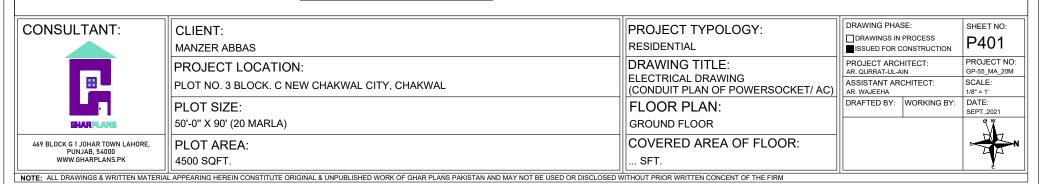

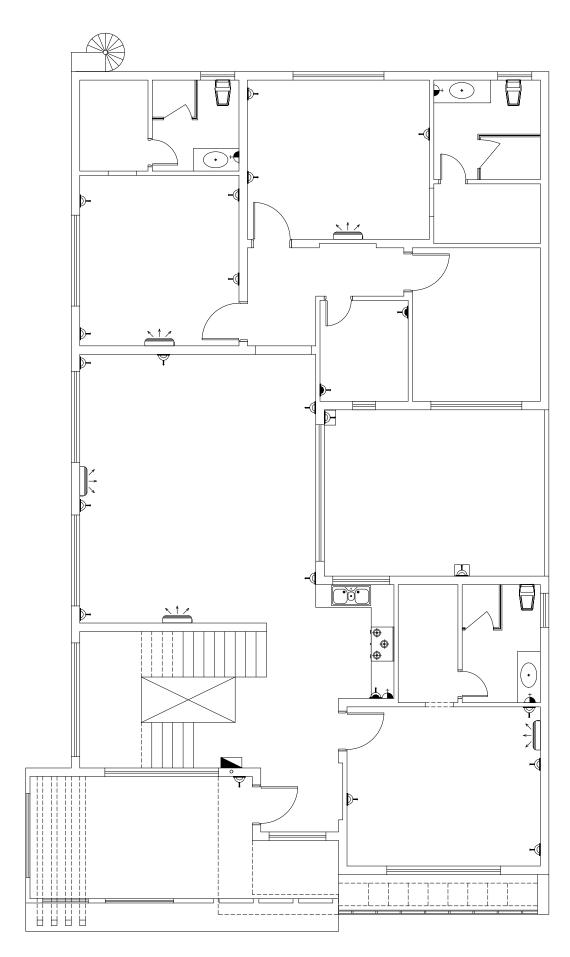

CONDUITS LAYOUT PLAN FOR POWER SOCKETS AND SPLIT AC's FIRST FLOOR

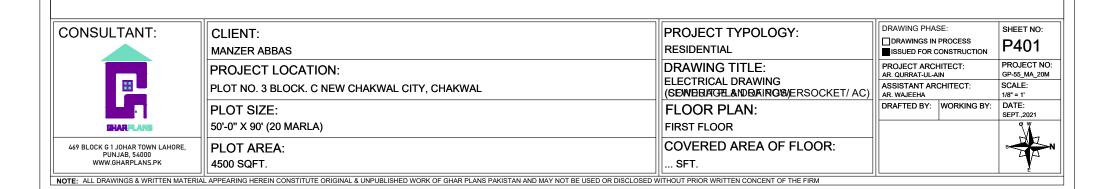

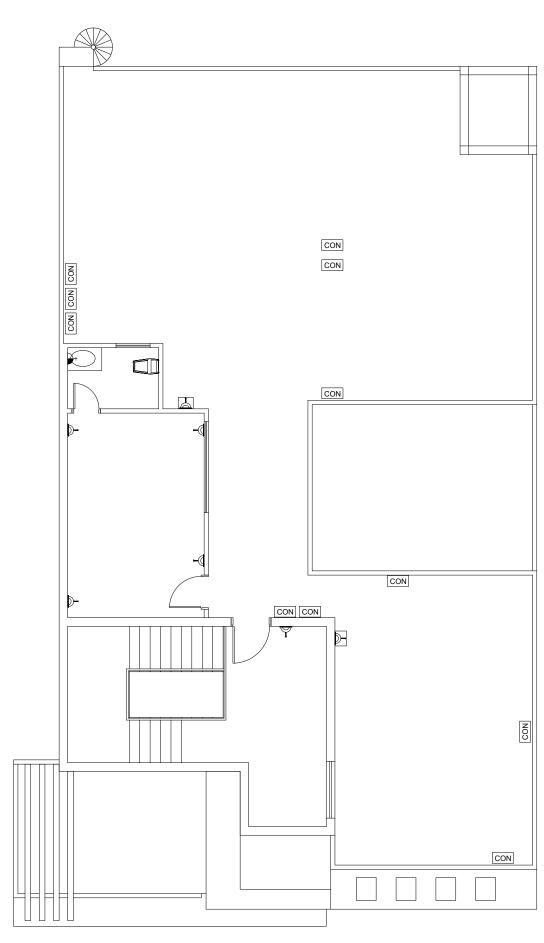

CONDUITS LAYOUT PLAN FOR POWER SOCKETS AND SPLIT AC's

ROOF



CONSULTANT:	CLIENT:	PROJECT TYPOLOGY:		
	MANZER ABBAS	RESIDENTIAL		
	PROJECT LOCATION:	DRAWING TITLE:		
	PLOT NO. 3 BLOCK. C NEW CHAKWAL CITY, CHAKWAL			
	PLOT SIZE:	FLOOR PLAN:		
BHARPLANE	50'-0" X 90' (20 MARLA)	SECOND FLOOR		
469 BLOCK G 1 JOHAR TOWN LAHORE, PUNJAB. 54000	PLOT AREA:	COVERED AREA OF FLOOR:		
WWW.GHARPLANS.PK	4500 SQFT.	SFT.		
NOTE: ALL DRAWINGS & WRITTEN MATERIAL APPEARING HEREIN CONSTITUTE ORIGINAL & UNPUBLISHED WORK OF GHAR PLANS PAKISTAN AND MAY NOT BE USED OR DISCLOSED WITHOUT PRIOR WRITTEN CONCENT OF THE FIRM				

DRAWING PHASE: SHEET NO: □ DRAWINGS IN PROCESS
■ ISSUED FOR CONSTRUCTION P401 PROJECT NO: GP-55_MA_20M PROJECT ARCHITECT: AR. QURRAT-UL-AIN ASSISTANT ARCHITECT: AR. WAJEEHA SCALE: 1/8" = 1' DRAFTED BY: WORKING BY: DATE: SEPT.,2021

